



Proposed Store:

Raising Cane's Site Sketch MAIN ST & WATERVIEW PKWY BOERNE, TX

PROTOTYPE 2

Architect Information:



Architectural Solutions Group

Site Data:

TBD
Front: -
Side: -
Rear: -
Zone: -
To be determined

Statisctics:	
Total area	72,259 sf
Parking Spaces	35
Required Spaces	36
Drive-Thru stack	-

Site Sketch


Date:	01/30/17
Revised:	03/08/17
Scale.	1" = 30'



Drawn By: PMDG

Study Number:

SD-3.0

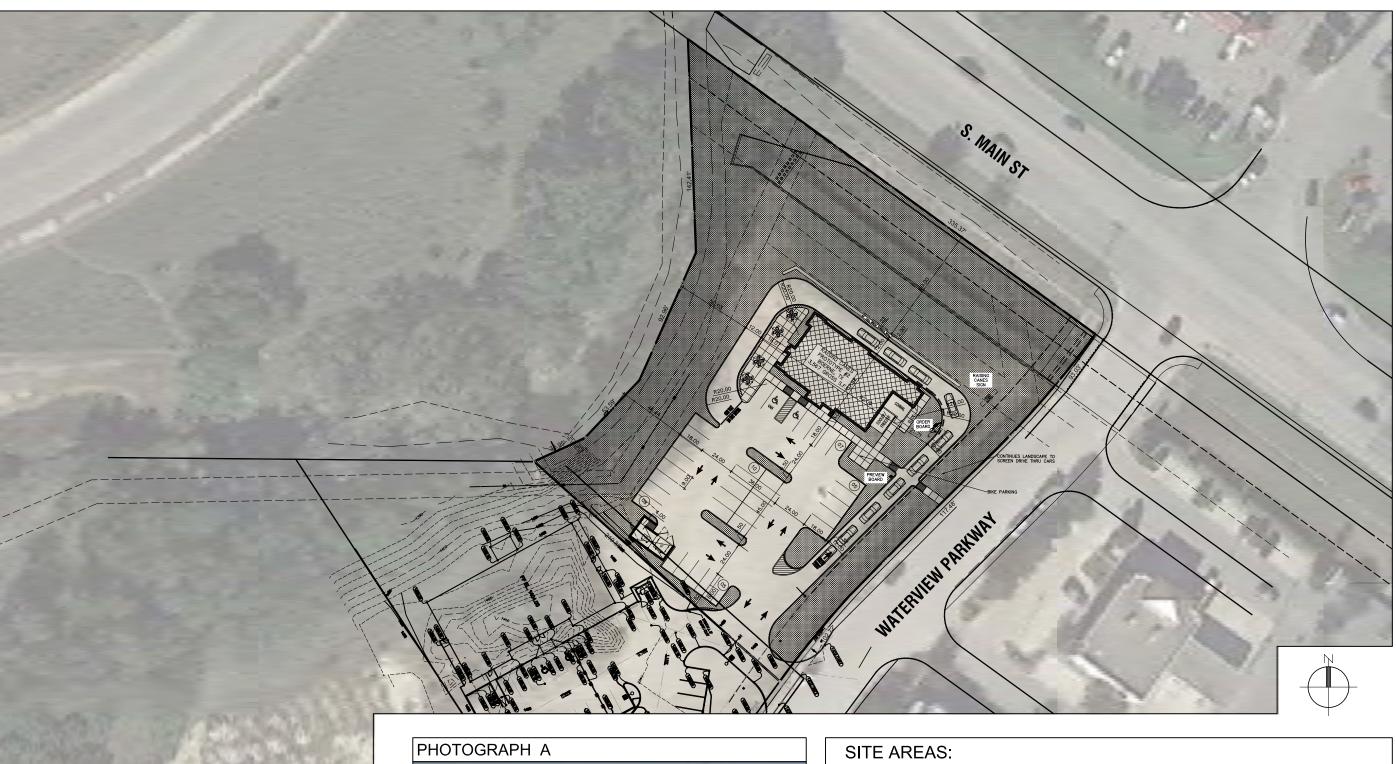



AREA OF CONCRETE PAVING (VEHICULAR USE)	23,994 SQ. FT.
GREEN OR LANDSCAPED AREA	44,698 SQ. FT.
BUILDING AREA	3,567 SQ. FT.
TOTAL SITE AREA	72,259 SQ.FT.
PARKING COUNT:	
TOTAL PARKING SPACES PROPOSED	35 (2 ACCESSIBLE SPACES
PARKING SPACES REQUIRED	36 (1/100)



Proposed Store:

Raising Cane's Site Sketch MAIN ST & WATERVIEW PKWY BOERNE, TX

PROTOTYPE 2

PACHIECI Information:

DESIGN


Architectural Solutions Group

Site Data:	
Zoning	TBD
Setbacks	Front: -
	Side: -
	Rear: -
Flood Zone	Zone: -
B.F.E	To be determined

Statisctics:	
Total area	72,259 sf
Parking Spaces	35
Required Spaces	36
Drive-Thru stack	-

Site Sketch


Date:	01/30/17
Revised:	03/08/17
Scale:	1" = 30'

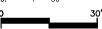

Drawn By: PMDG

Study Number:

SD-3.1

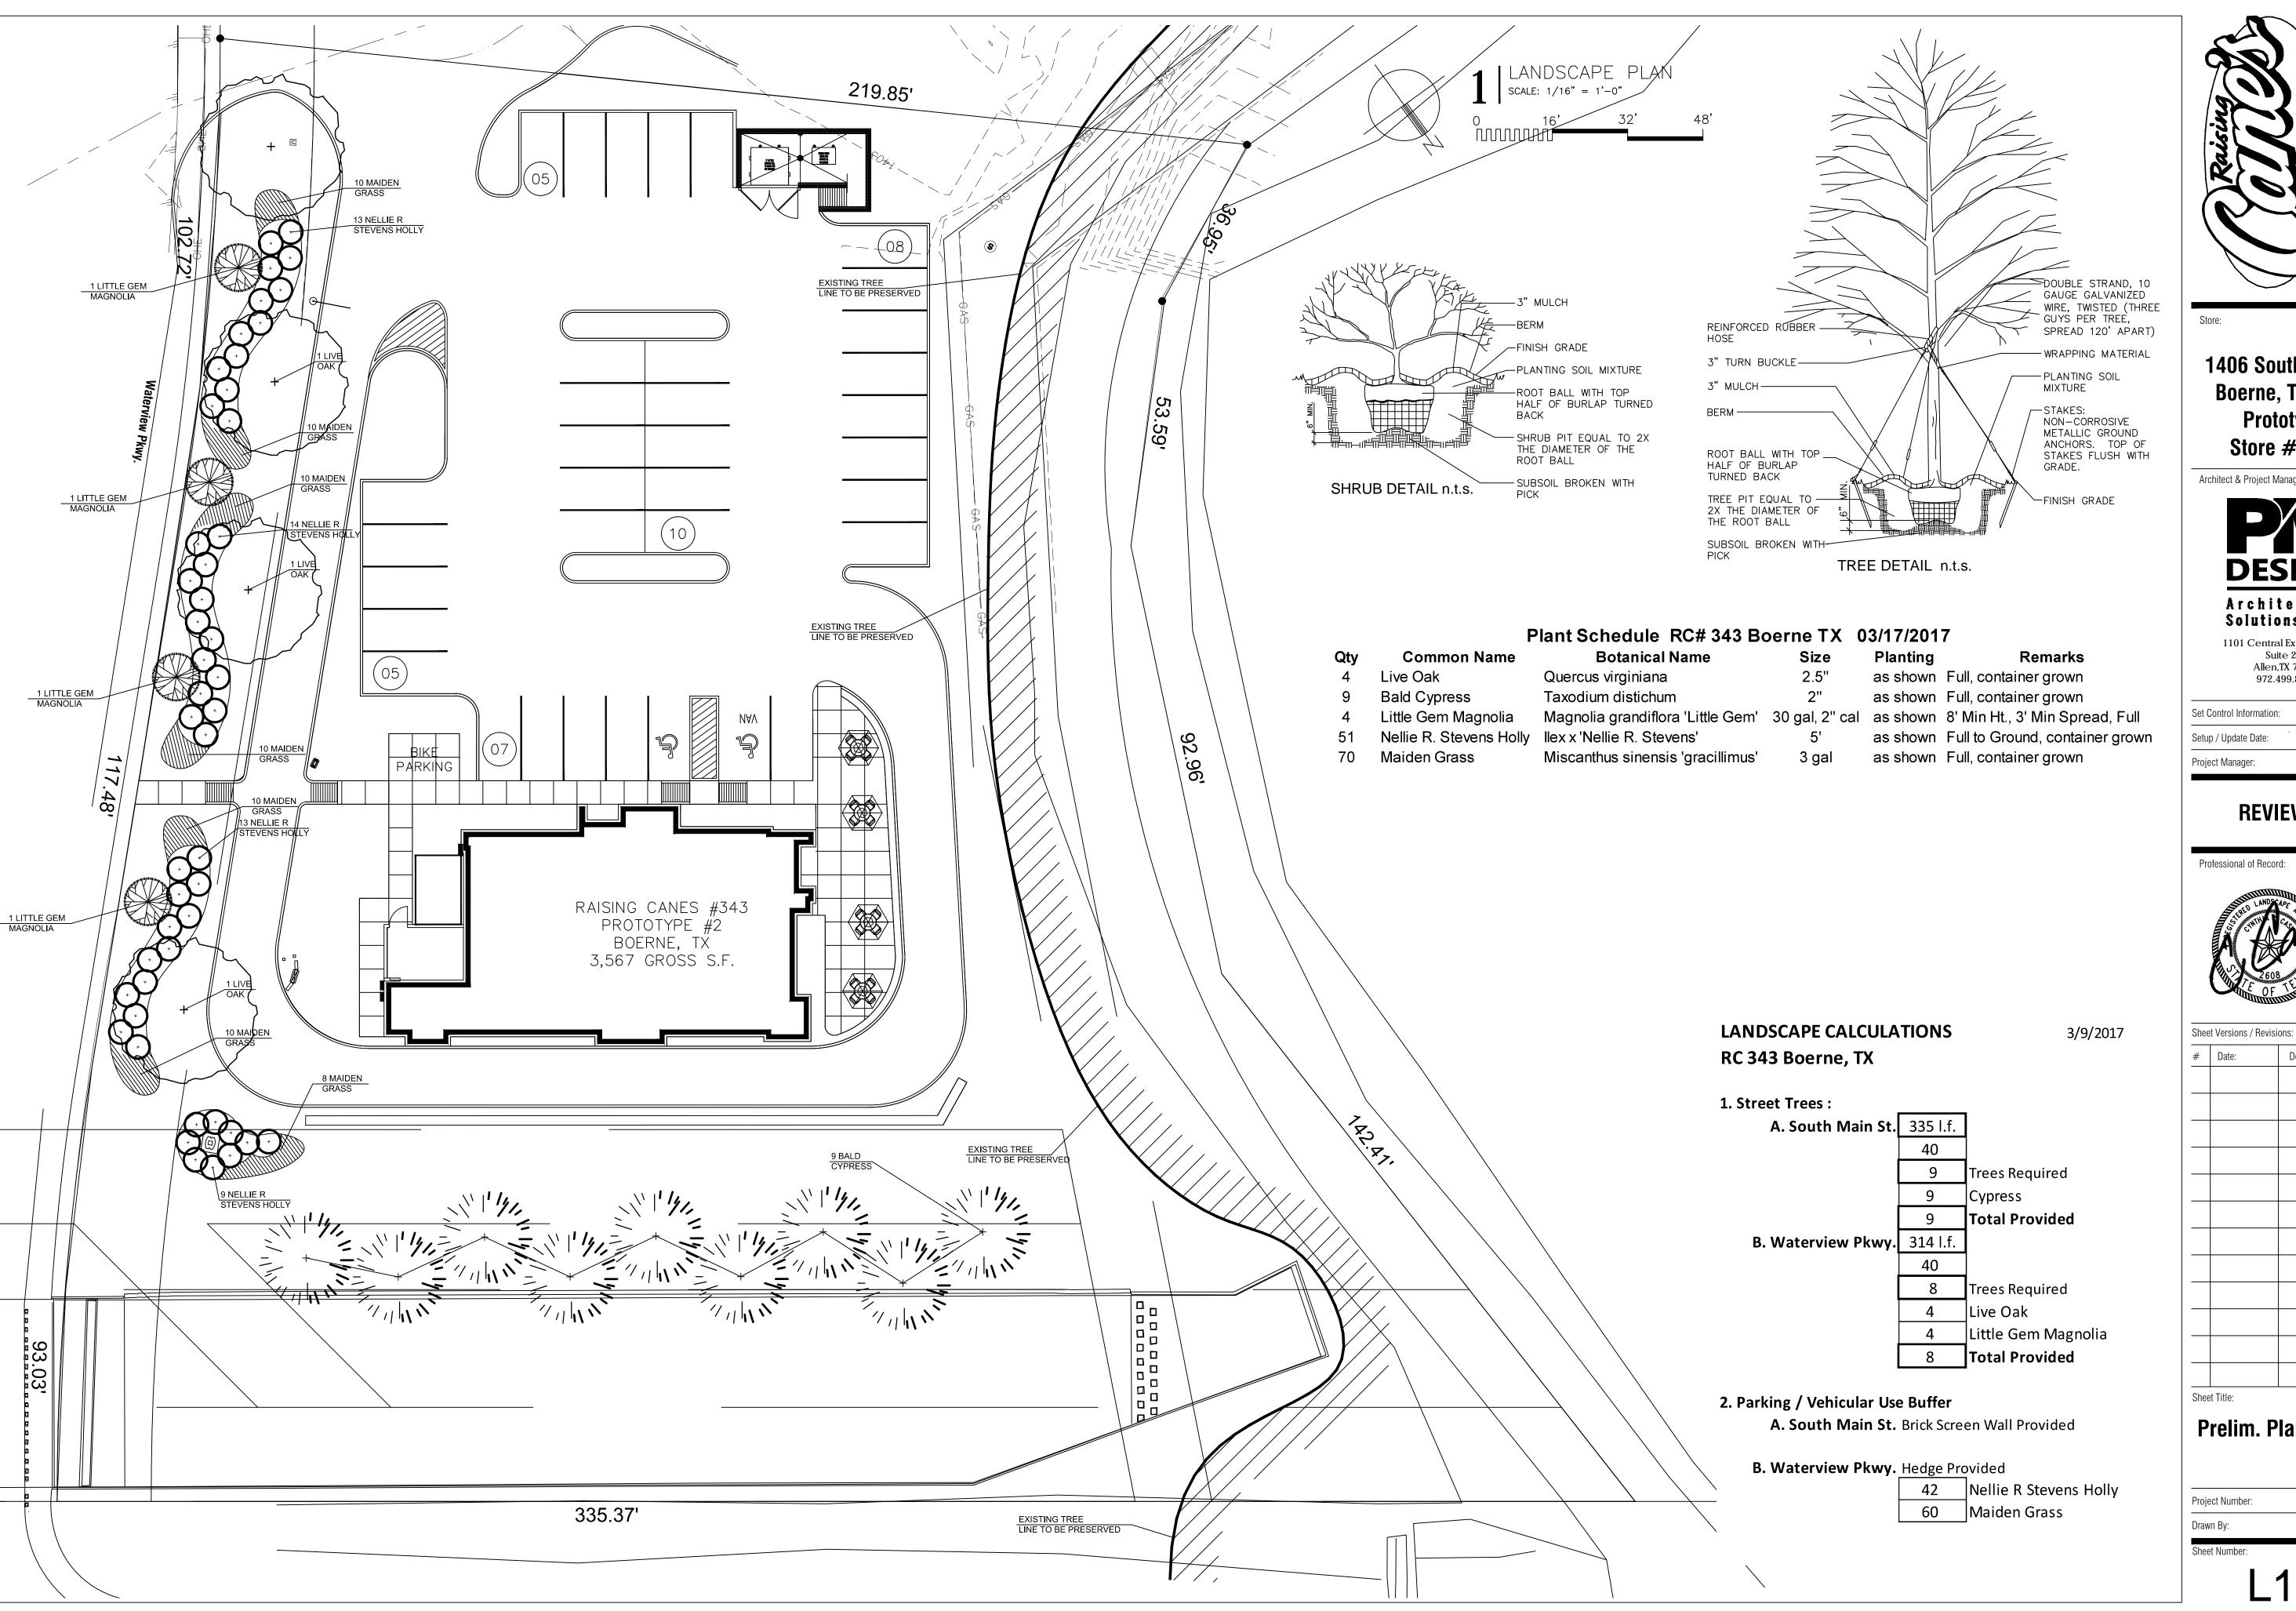

1406 South Main ST **Boerne, TX 78006 Prototype 2** Store #RC343

Architect & Project Manager:




1101 Central Expressway S. Suite 220 Allen,TX 75013 972.499.8084

3.21.17

Set Control Information:


REVIEW SET

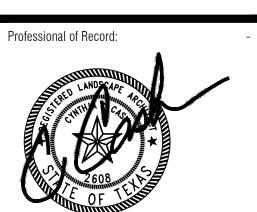

Description:

Prelim. Planting Plan

Project Number:	RAC16069.0
Drawn By:	CCC / FJS 03-09-2017
Charat Namela au	

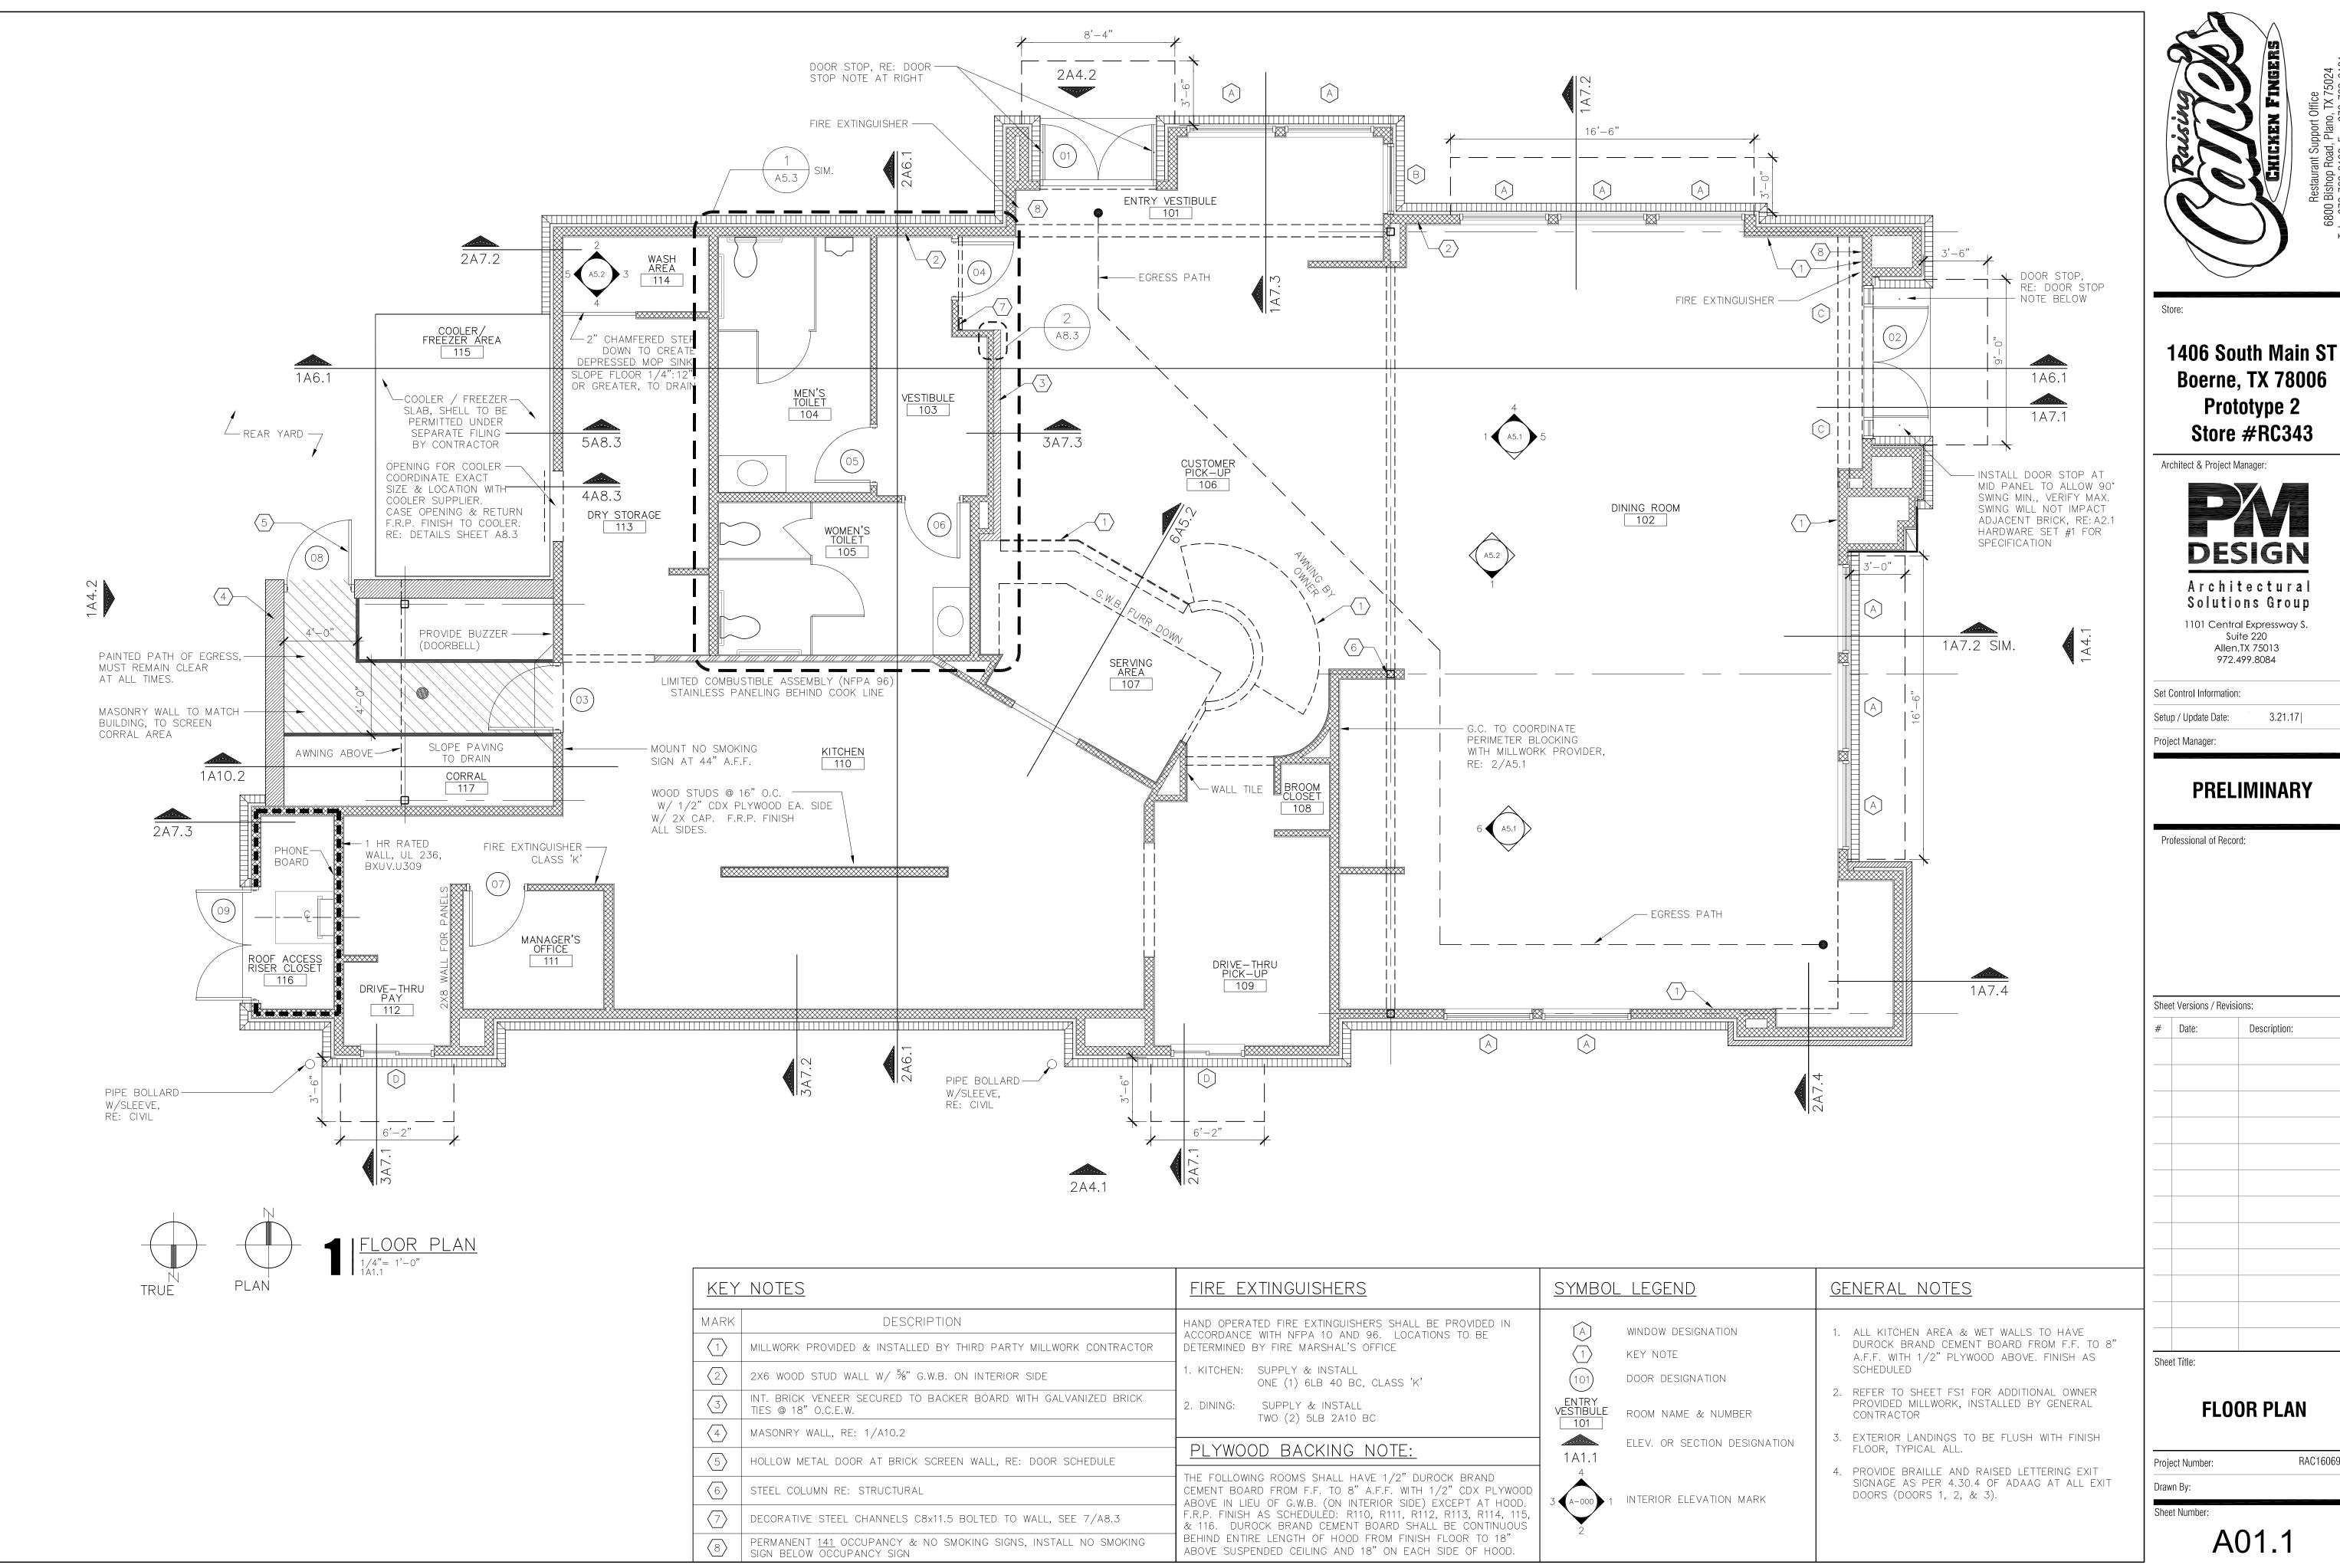

Boerne, TX 78006 Prototype 2



1101 Central Expressway S.

Description:

FLOOR PLAN

Project Number:	RAC16069.0
Drawn By:	- -



DESCRIPTION
STANDING SEAM METAL ROOF MATTE BLACK
METAL CAP FLASHING MATTE BLACK
PRE-FAB METAL CANOPY MATTE BLACK
ROOF SCUPPER AND DOWN SPOUT MATTE BLACK
STAINLESS STEEL COVER PANEL
FACE BRICK VENEER BORAL MODULAR ALAMO
STUCCO FINISH DRYVIT HONEY TWIST #383
ALUMINUM STOREFRONT KAWNEER TRIFAB 451 II ANODIZED
PAINT TO MATCH DRYVIT HONEY TWIST #383

FRONT ELEVATION:		
MATERIAL	AREA (SQ. FT)	COVERAGI
STUCCO	591	71%
MASONRY	107	13%
GLAZING (D+W)	133	16%
TOTAL SF	831	100%
DRIVE-THRU ELEVATION	N:	
MATERIAL	AREA (SQ. FT)	COVERAGE
STUCCO	774	48%
MASONRY	611	38%
GLAZING (D+W)	220	14%
TOTAL SF	1,605	100%
REAR ELEVATION:		
MATERIAL	AREA (SQ. FT)	COVERAGE
STUCCO	624	75%
MASONRY	187	23%
GLAZING (D+W)	24	2%
TOTAL SF	837	100%
SIDE ELEVATION:		
MATERIAL	AREA (SQ. FT)	COVERAGE
STUCCO	1,188	72%
MASONRY	239	15%
GLAZING (D+W)	220	13%
TOTAL SF	1,647	100%



Store:

1406 South Main ST Boerne, TX 78006 Prototype 2 Store #RC343

Architect & Project Manager:



1101 CENTRAL EXPRESSWAY S. SUITE 220 ALLEN, TX 75013 PH. (972) 499-8084

3.21.17

Set Control Information:

Setup / Update Date:

Project Manager:

PRELIMINARY

Professional of Record:


Sheet Versions / Revisions:

PRESENTATION ELEVATIONS

Project Number: RA

neet Number:



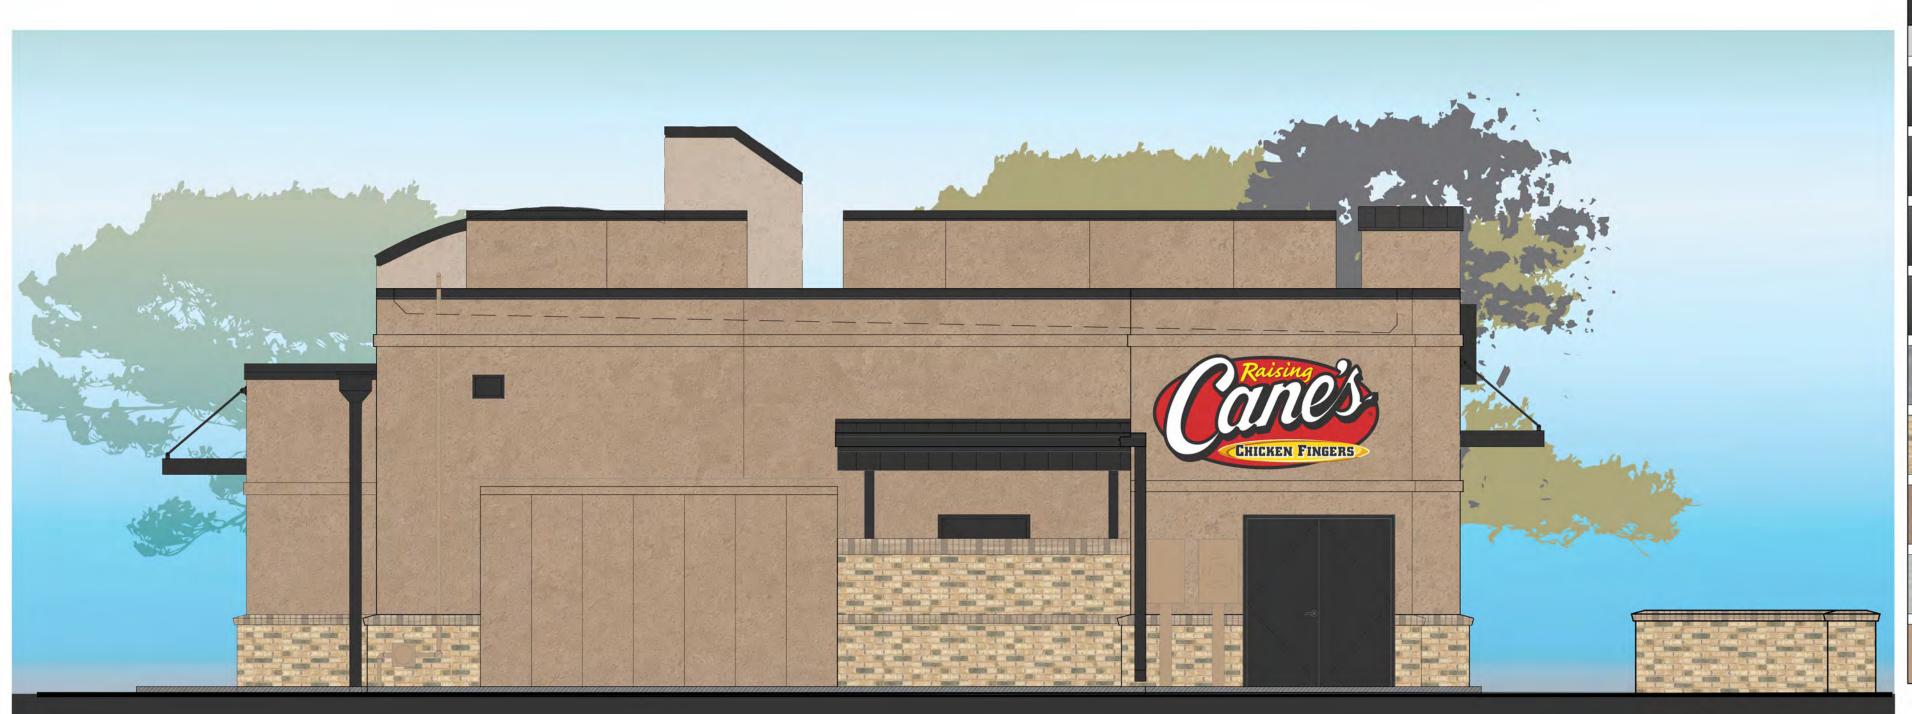

DESCRIPTION
STANDING SEAM METAL ROOF MATTE BLACK
METAL CAP FLASHING MATTE BLACK
PRE-FAB METAL CANOPY MATTE BLACK
ROOF SCUPPER AND DOWN SPOUT MATTE BLACK
STAINLESS STEEL COVER PANEL
FACE BRICK VENEER BORAL MODULAR ALAMO
STUCCO FINISH DRYVIT HONEY TWIST #383
ALUMINUM STOREFRONT KAWNEER TRIFAB 451 II ANODIZED
PAINT TO MATCH DRYVIT HONEY TWIST #383

FRONT ELEVATION:		-
MATERIAL	AREA (SQ. FT)	COVERAGE
STUCCO	591	71%
MASONRY	107	13%
GLAZING (D+W)	133	16%
TOTAL SF	831	100%
DRIVE-THRU ELEVATION:		
MATERIAL	AREA (SQ. FT)	COVERAGE
STUCCO	774	48%
MASONRY	611	38%
GLAZING (D+W)	220	14%
TOTAL SF	1,605	100%
REAR ELEVATION:		
MATERIAL	AREA (SQ. FT)	COVERAGE
STUCCO	624	75%
MASONRY	187	23%
GLAZING (D+W)	24	2%
TOTAL SF	837	100%
SIDE ELEVATION:		
MATERIAL	AREA (SQ. FT)	COVERAGE
STUCCO	1,188	72%
MASONRY	239	15%
GLAZING (D+W)	220	13%
TOTAL SF	1,647	100%



Store.

1406 South Main ST Boerne, TX 78006 Prototype 2 Store #RC343

Architect & Project Manager:



1101 CENTRAL EXPRESSWAY S. SUITE 220 ALLEN, TX 75013 PH. (972) 499-8084

Set Control Information:

Setun / Undate Date:

Project Manager:

PRELIMINARY

Professional of Record:

Sheet Versions / Revisions:

Date: Description:

Sheet Tit

PRESENTATION ELEVATIONS

Project Number: RAC1606

Drawn By:

P-4.2



REAR ELEVATION

1/4"= 1'-0"

01: A4.2